



METRIC
ALL DIMENSIONS SHOWN ARE IN METRES AND/OR MILLIMETRES UNLESS OTHERWISE NOTED.

NOTES:


1. PROVIDE UNISTRUT CHANNEL AS NOTED ON DRAWING.
2. REFER TO ELECTRIFICATION STANDARDS AND SPECIFICATIONS FOR GROUNDING AND BONDING, EMI/EMF WITHSTAND REQUIREMENTS, CABLING REQUIREMENTS.

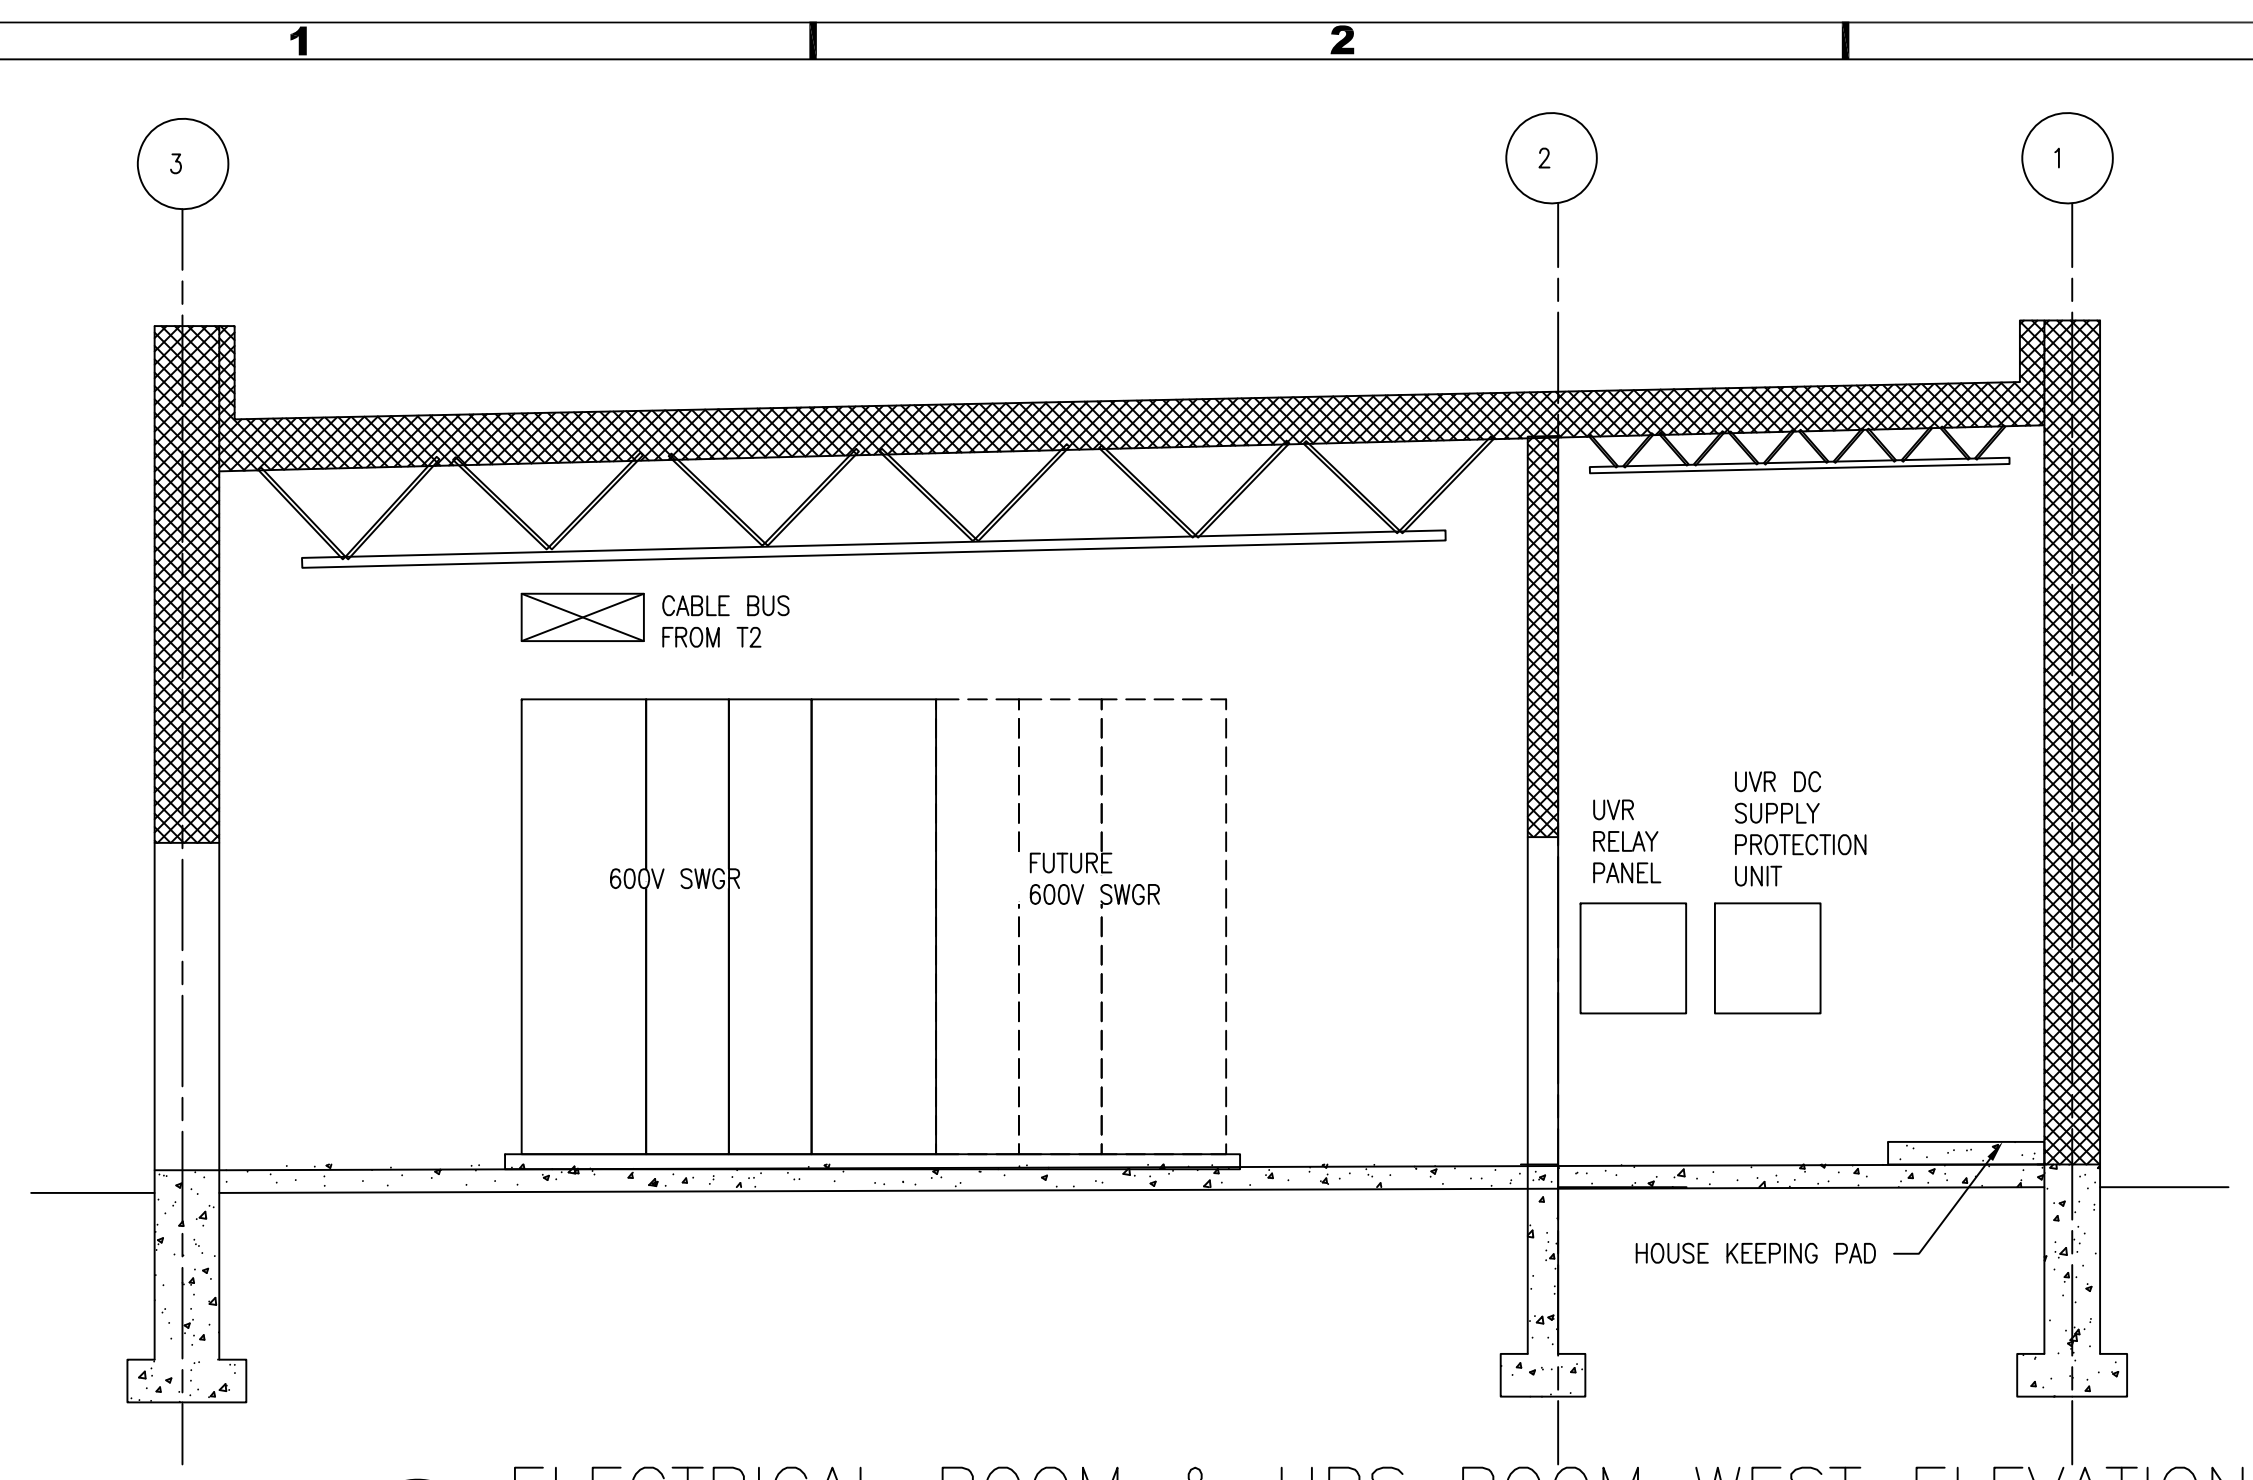


1 ELECTRICAL ROOM & UPS ROOM WEST ELEVATION
WSP-104 NTS

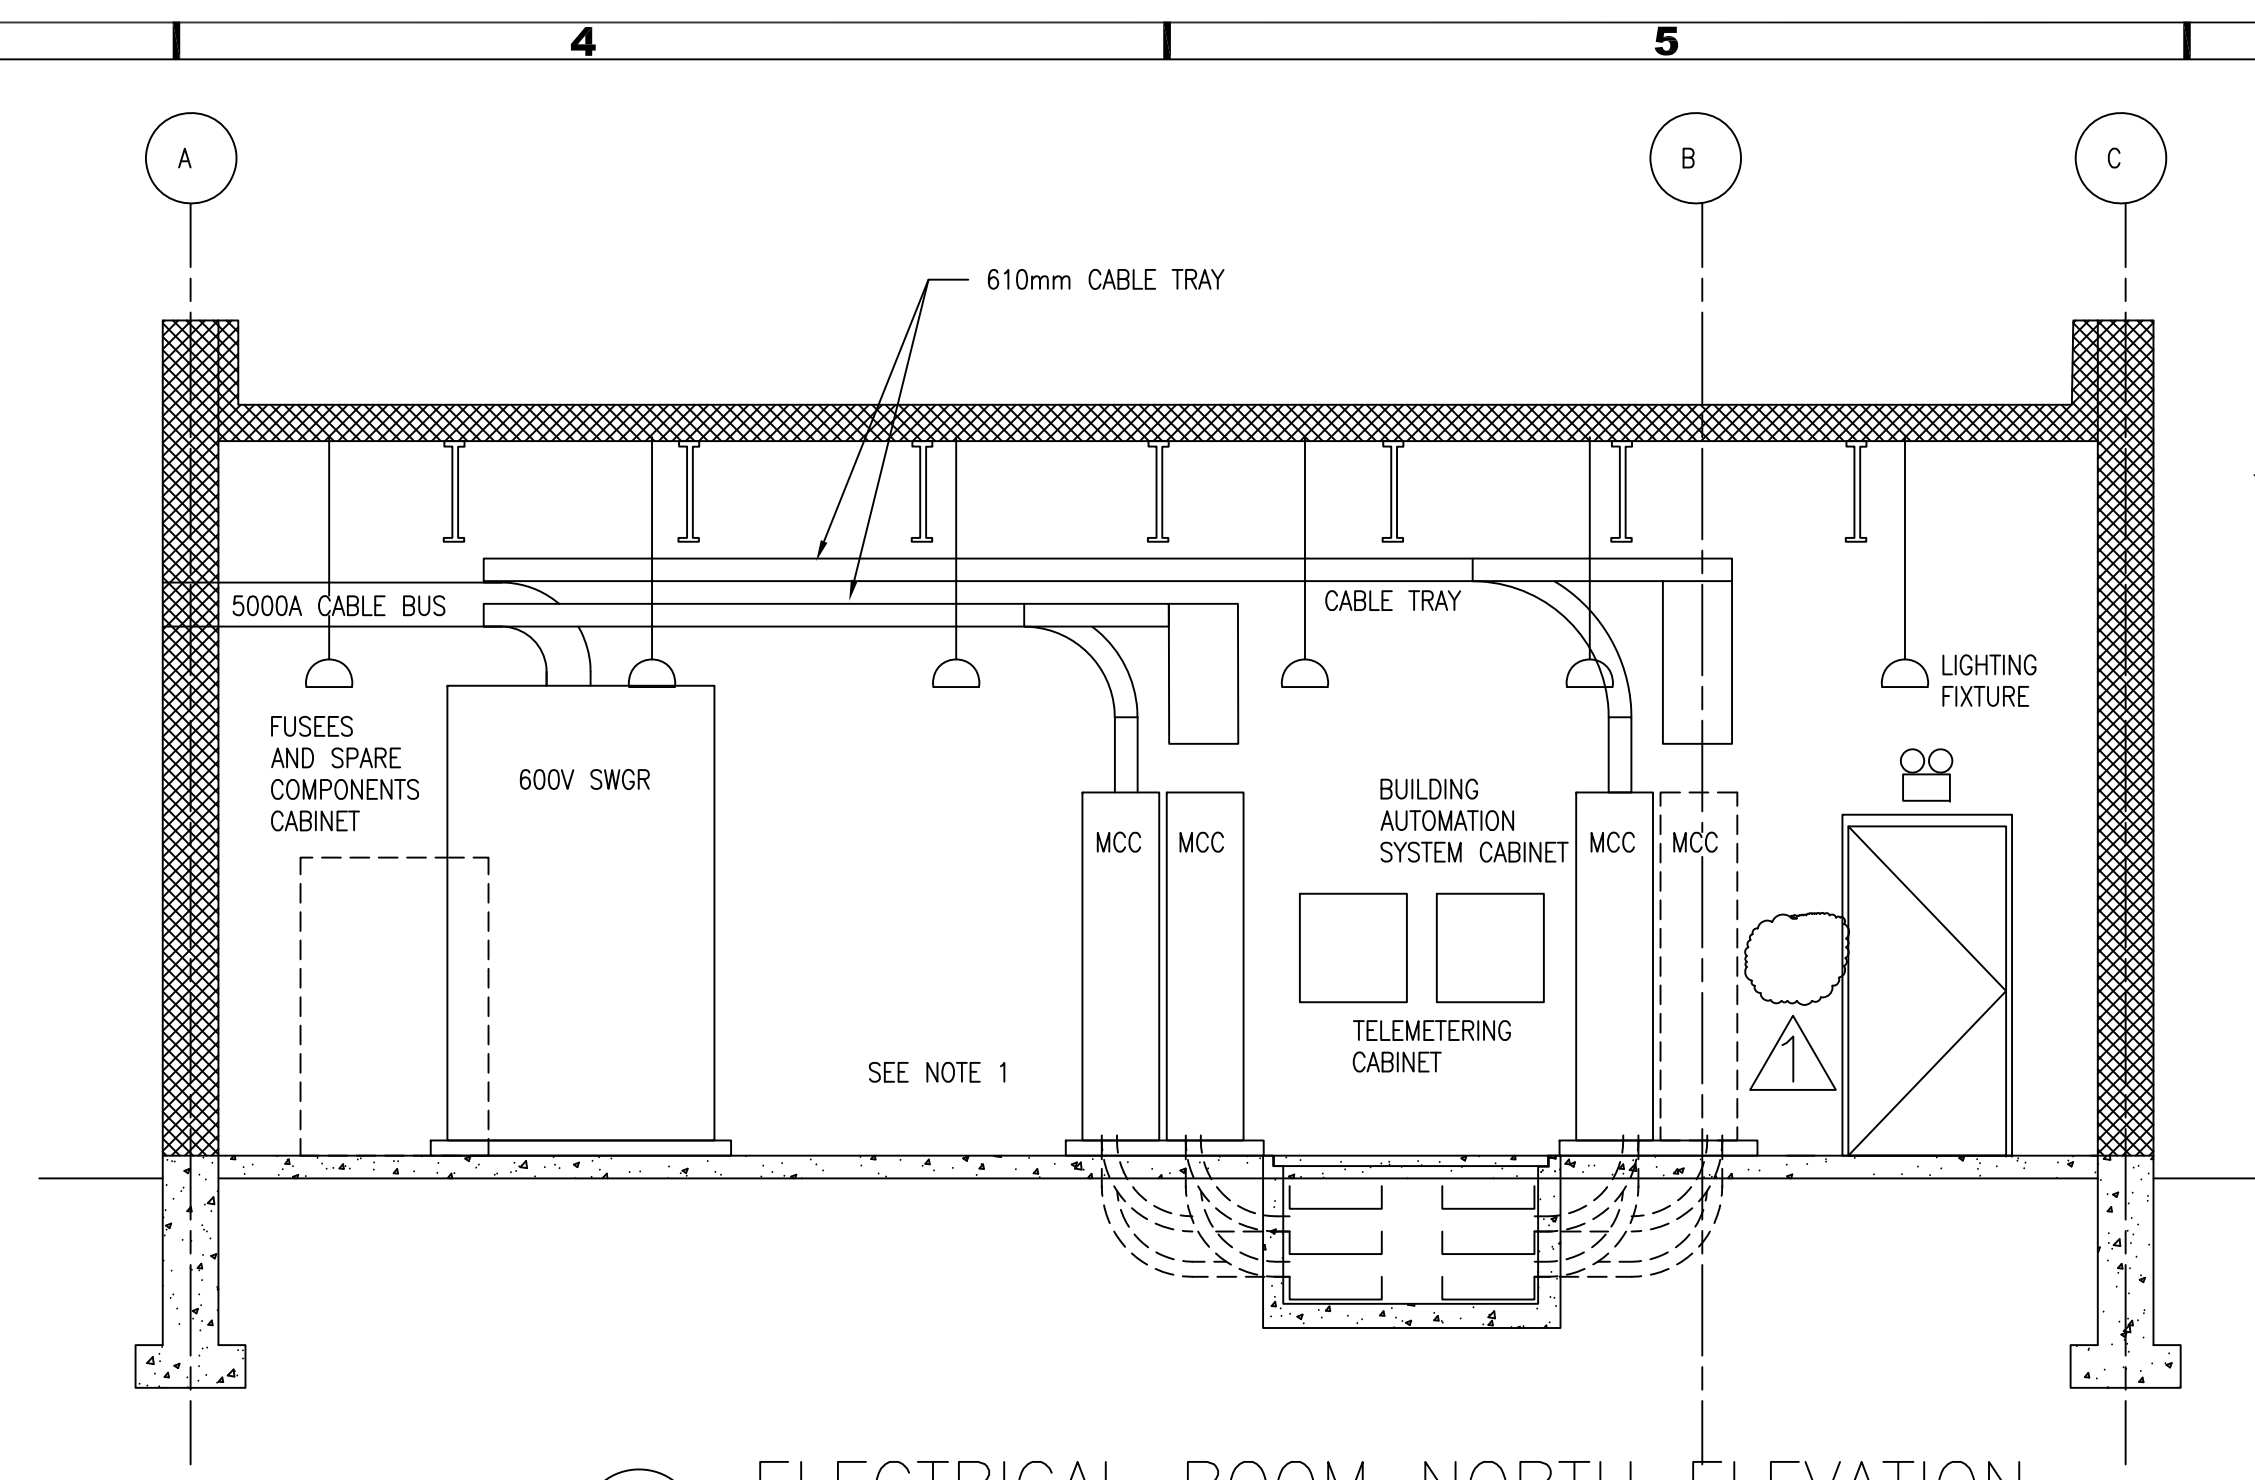

3 ELECTRICAL ROOM NORTH ELEVATION
WSP-104 NTS

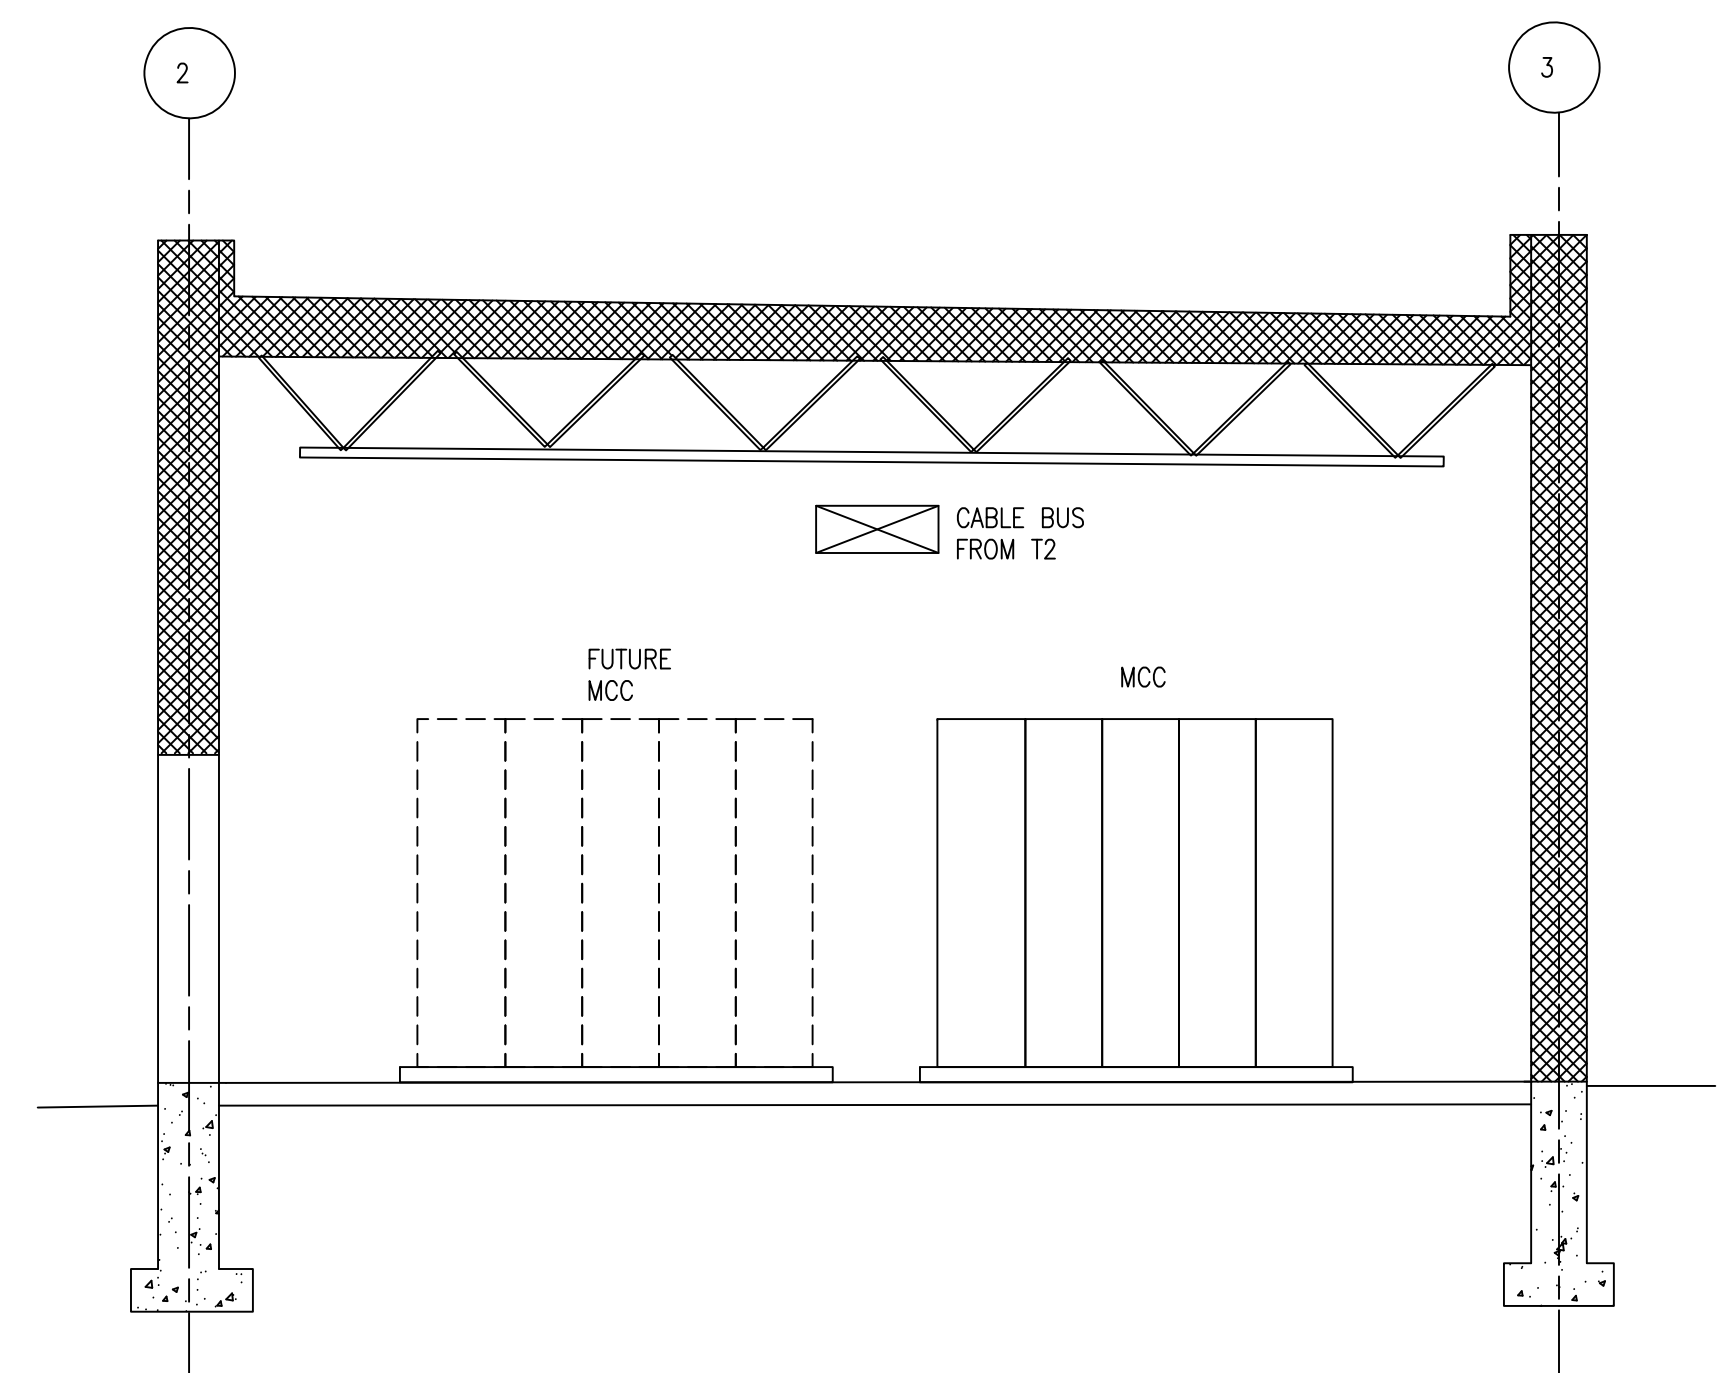

2 ELECTRICAL ROOM EAST ELEVATION
WSP-104 NTS

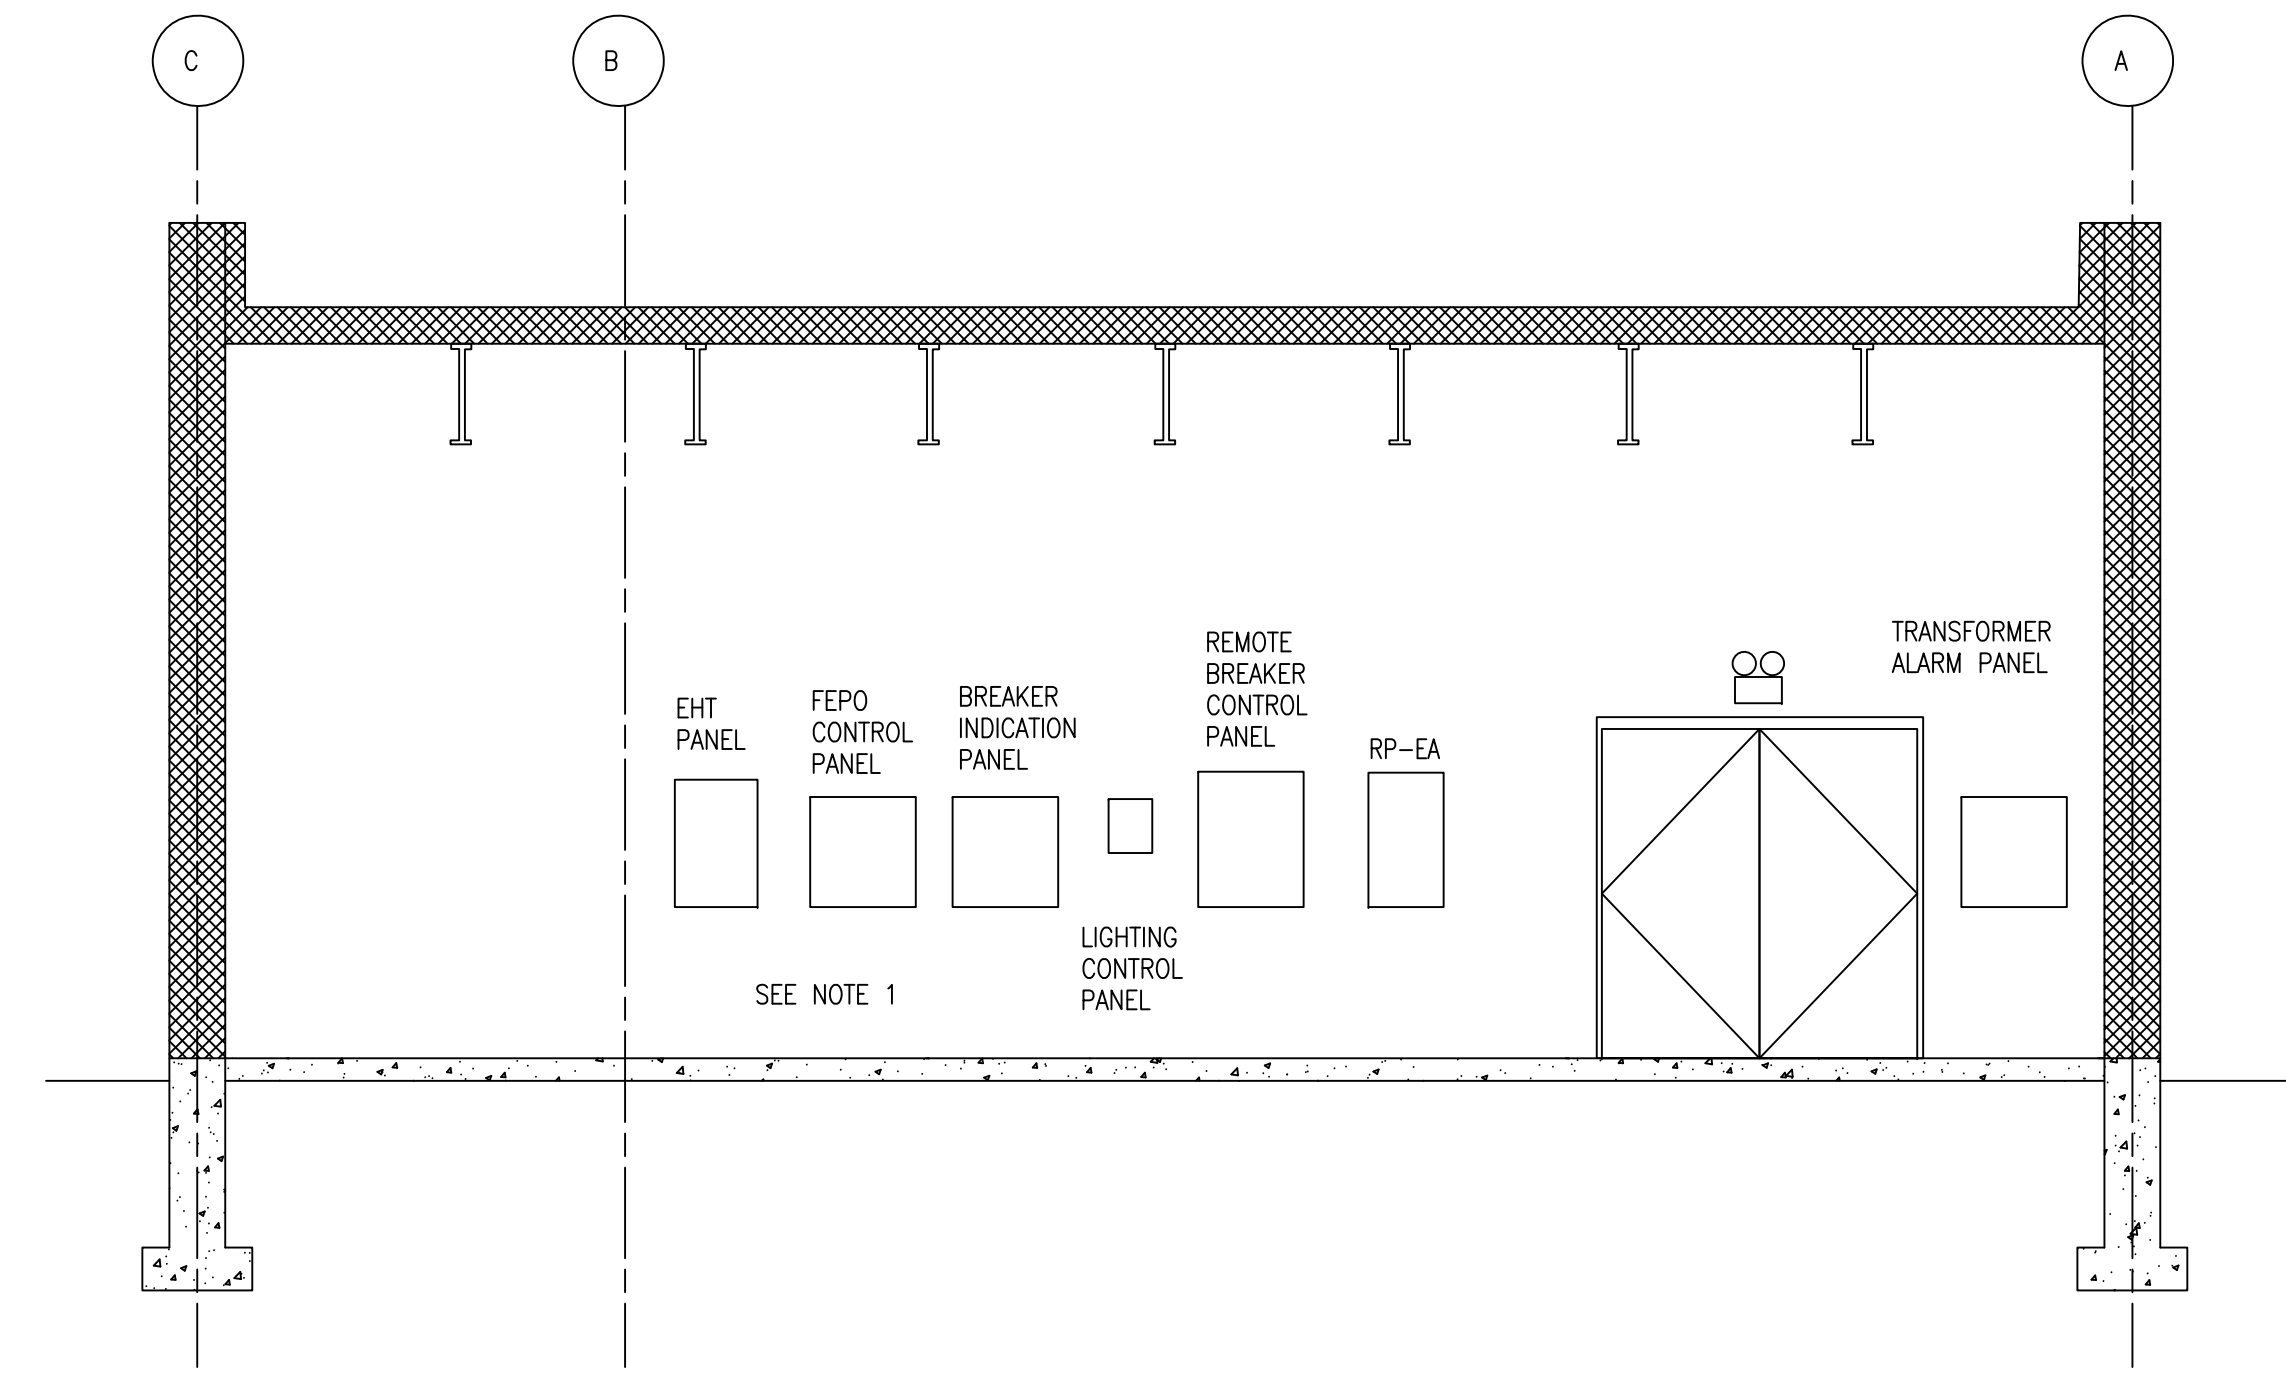

4 ELECTRICAL ROOM SOUTH ELEVATION
WSP-104 NTS

NOTE:
THIS DRAWING IS PROVIDED FOR INSTRUCTIONAL DESIGN PURPOSES ONLY BASED ON METROLINX GO TRANSIT DESIGN GUIDELINES AND REQUIREMENTS. THE CONSULTANT SHALL VERIFY FOR LOCAL CODE COMPLIANCE, EXISTING SITE CONDITIONS AND INTER DISCIPLINARY DRAWING COORDINATION. ALL DIMENSIONS AND SPECIFICATIONS SHOULD BE VERIFIED BY CONSULTANT AND/OR CONTRACTOR BEFORE ACTUAL CONSTRUCTION BEGINS.

GO TRANSIT PROJECT NO. XXXXX

REFERENCE DRAWINGS	ISSUE	REVISIONS
DWG NO.	TITLE	REV. DATE ISSUED FOR

DRAWN BY:	DESIGNED BY:
CHECKED BY:	APPROVED BY:
SCALE: NTS	FULL SIZE ONLY



XXXXXX WAYSIDE POWER SUBSTATION BUILDING ELEVATIONS 1 OF 2			
CONTRACT NO. XXXXXXXXXX	DWG. NO. WSP-046	REV. 1	SHEET XX