

D SIZE 22" x 34" (558.8mm x 863.6mm)

METRIC


ALL DIMENSIONS SHOWN ARE IN METRES AND/OR MILLIMETRES UNLESS OTHERWISE NOTED.

NOTES:

1. REFER TO ELECTRIFICATION STANDARDS AND SPECIFICATIONS FOR GROUNDING AND BONDING, EMI/EMF WITHSTAND REQUIREMENTS, CABLING REQUIREMENTS

NOTE: THIS DRAWING IS TO BE USED ONLY AS A REFERENCE DRAWING FOR EXISTING INSTALLATIONS AND EXPANSION OF EXISTING EQUIPMENT AS NECESSARY. NOT TO BE USED IN NEW DESIGNS.

NOTE: THIS DRAWING IS PROVIDED FOR INSTRUCTIONAL DESIGN PURPOSES ONLY BASED ON METROLINX GO TRANSIT DESIGN GUIDELINES AND REQUIREMENTS. THE CONSULTANT SHALL VERIFY FOR LOCAL CODE COMPLIANCE, EXISTING SITE CONDITIONS AND INTER DISCIPLINARY DRAWING COORDINATION. ALL DIMENSIONS AND SPECIFICATIONS SHOULD BE VERIFIED BY CONSULTANT AND/OR CONTRACTOR BEFORE ACTUAL CONSTRUCTION BEGINS.

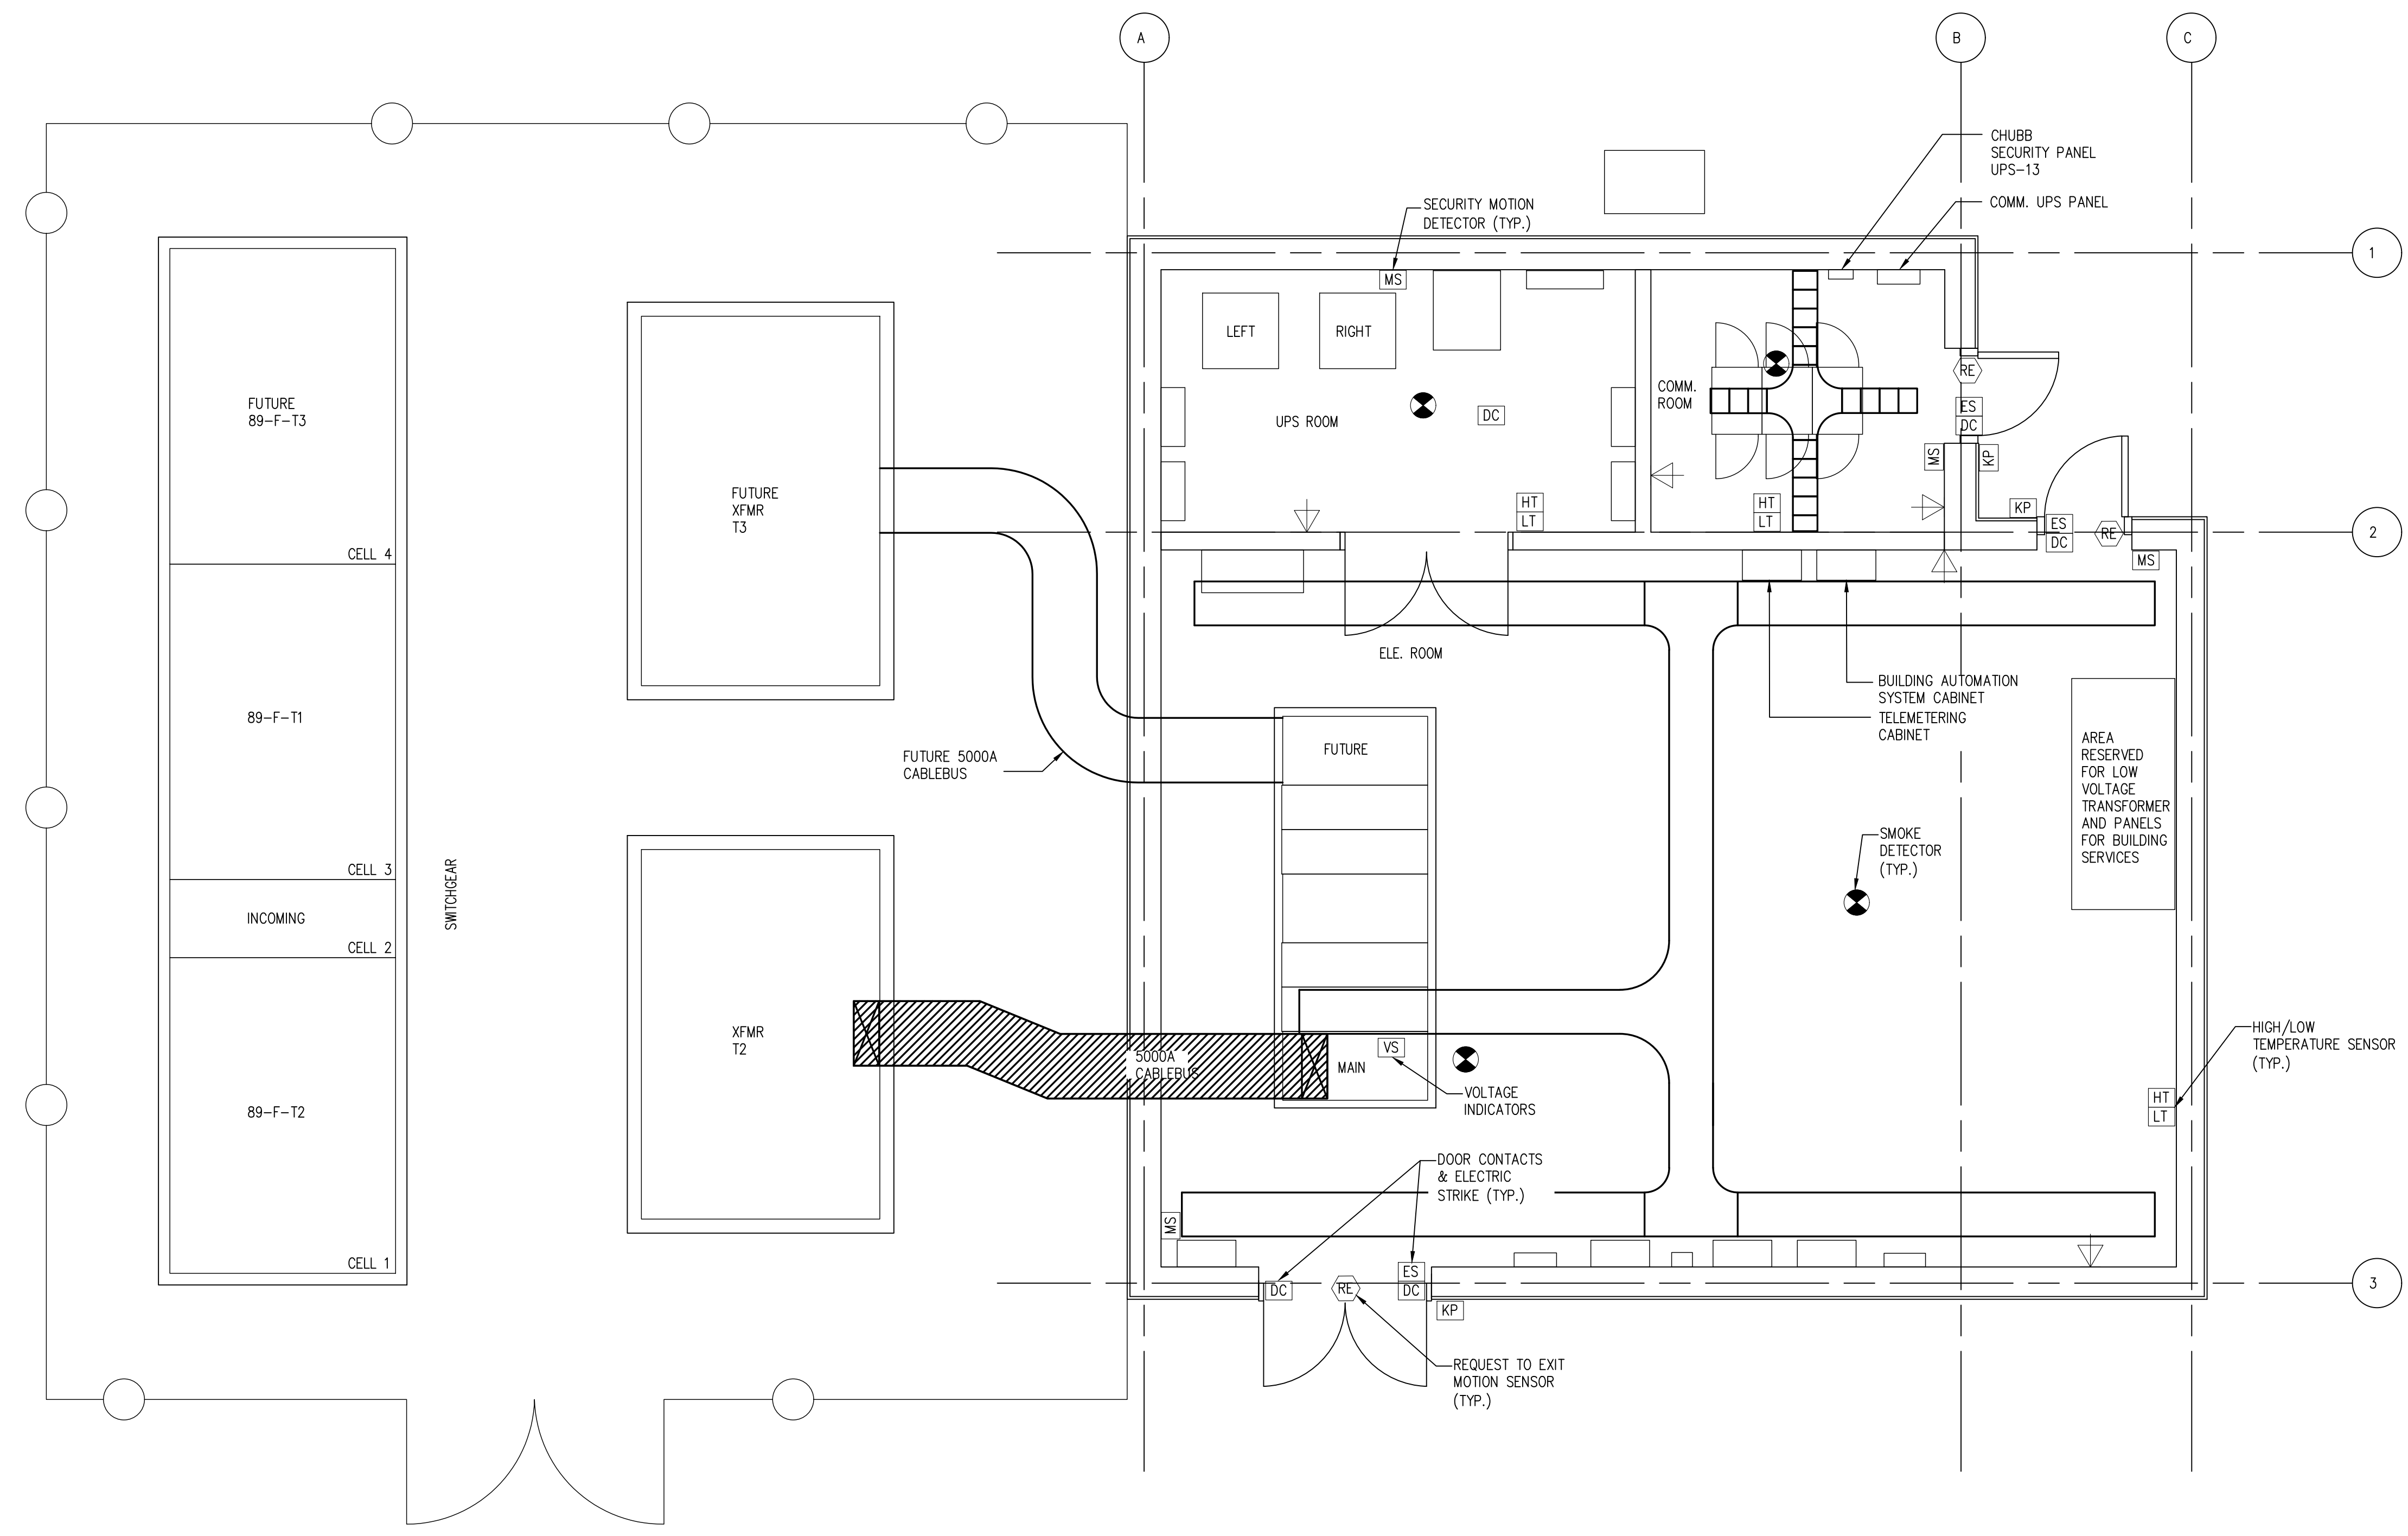

1 SUBSTATION COMMUNICATION AND SECURITY LAYOUT
1:50

Aug 15, 2018, 12:33pm, Login name: orade5969
 Drawing Name: C:\Users\orade5969\Desktop\WSP\WSP-145.dwg

GO TRANSIT PROJECT NO. XX

REFERENCE DRAWINGS		ISSUE		REVISIONS		DRAWN BY: XX XX	DESIGNED BY: XX XX		XXXXXX WAYSIDE POWER SUBSTATION BUILDING COMMUNICATION AND SECURITY LAYOUT			
						CHECKED BY: XX XX	APPROVED BY: XX XX		CONTRACT NO. XX	DWG. NO. WSP-145	REV. 0	SHEET XX XX
						SCALE: N.T.S. FULL SIZE ONLY						
DWG. NO.	TITLE	REV.	DATE	ISSUED FOR	REV.	DATE						