


ALL DIMENSIONS SHOWN ARE IN METRES AND/OR MILLIMETRES UNLESS OTHERWISE NOTED.

NOTES:

1. PROVIDE PLYWOOD BACKBOARD AS PER SPECIFICATIONS FOR COMM. ROOM WALL.
2. PROVIDE UNISTRUT CHANNELS AS NOTED ON DRAWING ELECTRICAL BUILDING GENERAL POWER LAYOUT.
3. REFER TO ELECTRIFICATION STANDARDS AND SPECIFICATIONS FOR GROUNDING AND BONDING, EMI/EMF WITHSTAND REQUIREMENTS, CABLING REQUIREMENTS


NOTE:
THIS DRAWING IS TO BE USED ONLY AS A REFERENCE DRAWING FOR EXISTING INSTALLATIONS AND EXPANSION OF EXISTING EQUIPMENT AS NECESSARY. NOT TO BE USED IN NEW DESIGNS.

NOTE:
THIS DRAWING IS PROVIDED FOR INSTRUCTIONAL DESIGN PURPOSES ONLY BASED ON METROLINX GO TRANSIT DESIGN GUIDELINES AND REQUIREMENTS. THE CONSULTANT SHALL VERIFY FOR LOCAL CODE COMPLIANCE, EXISTING SITE CONDITIONS AND INTER DISCIPLINARY DRAWING COORDINATION. ALL DIMENSIONS AND SPECIFICATIONS SHOULD BE VERIFIED BY CONSULTANT AND/OR CONTRACTOR BEFORE ACTUAL CONSTRUCTION BEGINS.

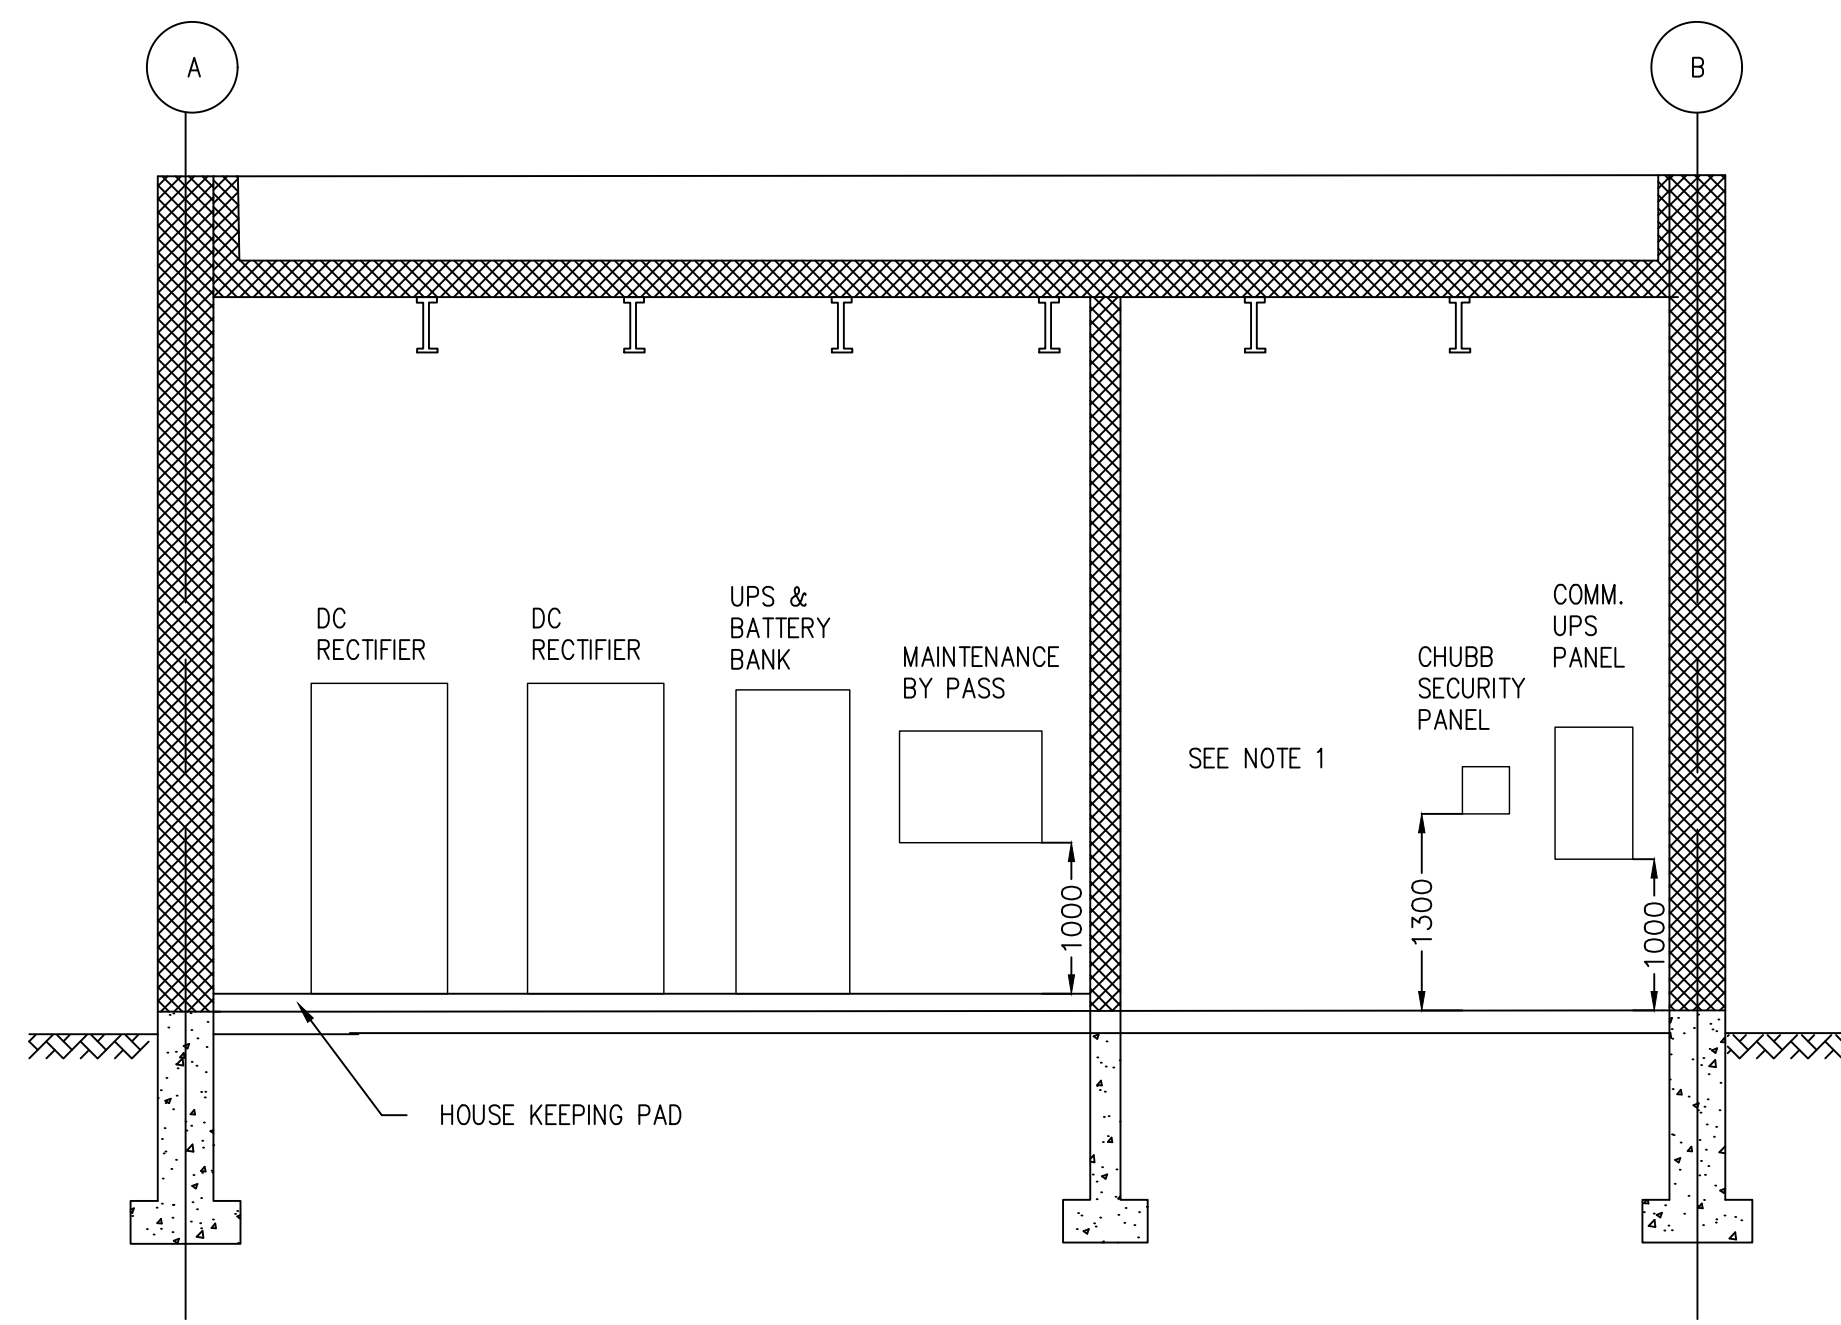


UPS/RECTIFIER ROOM & COMMUNICATION ROOM
NORTH ELEVATION

1
WSP-104 1:50

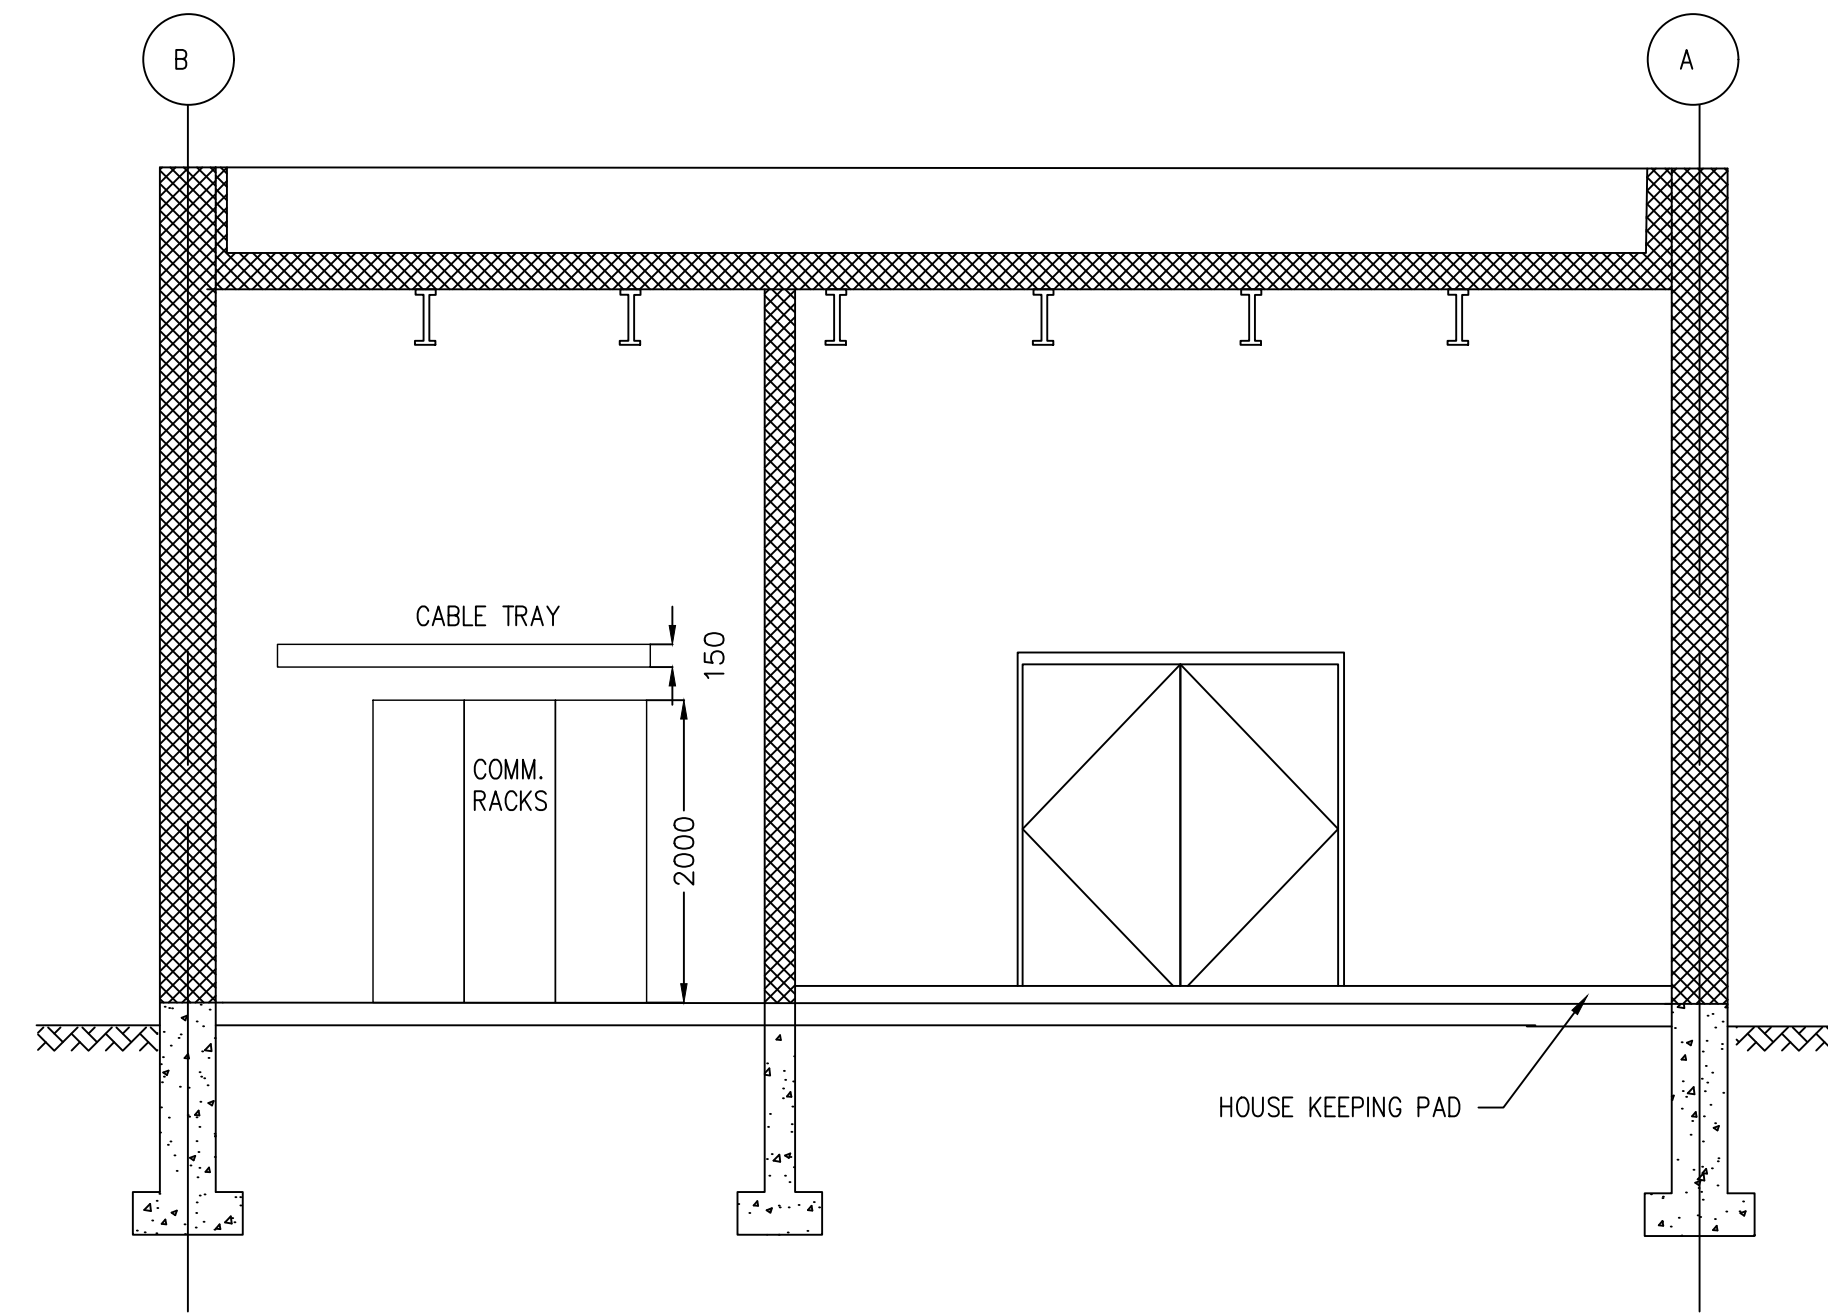

UPS/RECTIFIER ROOM & COMMUNICATION ROOM
SOUTH ELEVATION

3
WSP-104 1:50

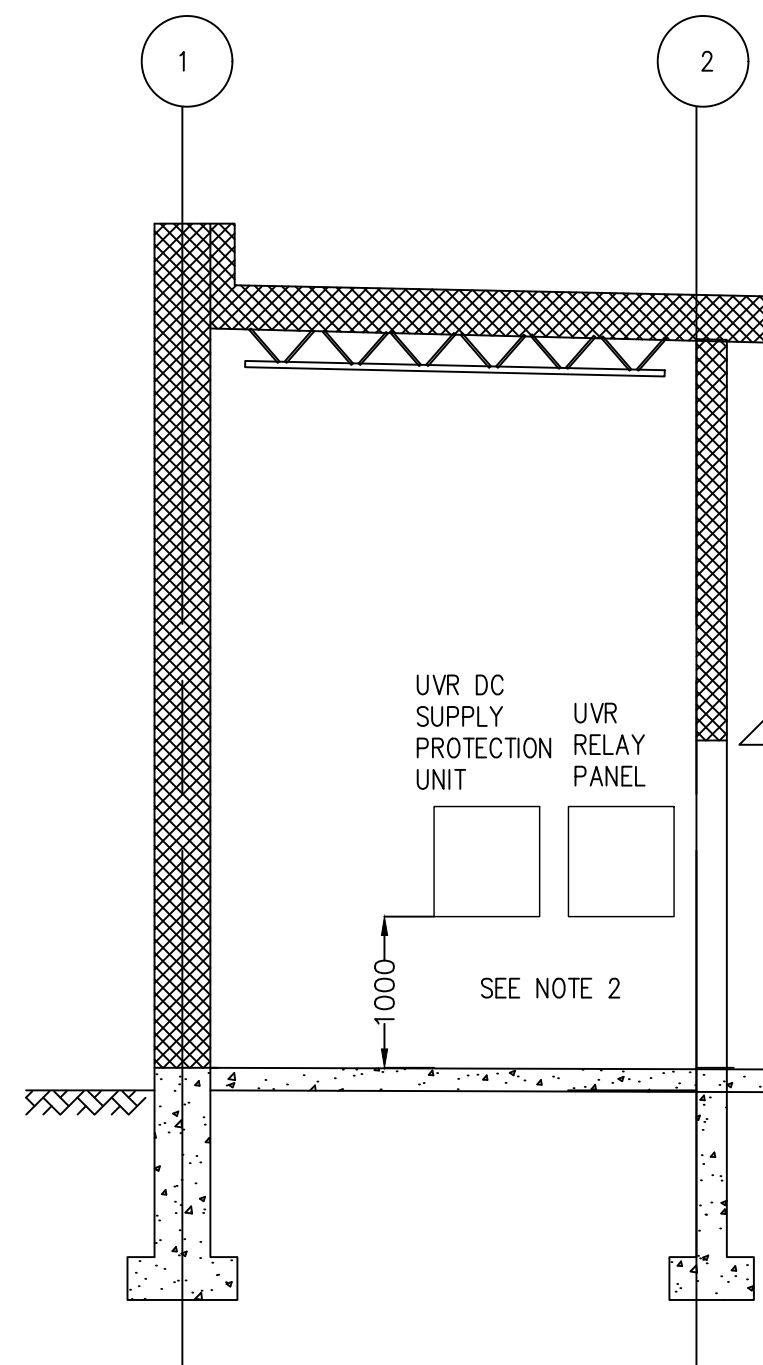

UPS ROOM EAST ELEVATION

2
WSP-104 1:50

GO TRANSIT PROJECT NO. XX

REFERENCE DRAWINGS	ISSUE	REVISIONS	DRAWN BY:	DESIGNED BY:
			XX XX	XX XX
			CHECKED BY:	APPROVED BY:
			XX XX	XX XX
			SCALE: N.T.S.	FULL SIZE ONLY
DWG. NO.	TITLE	REV. DATE	ISSUED FOR	REV. DATE



XXXXXX
WAYSIDE POWER
SUBSTATION BUILDINGS
ELEVATIONS 2 OF 2

CONTRACT NO. XX	DWG. NO. WSP-147	REV. 0	SHEET XX XX
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